
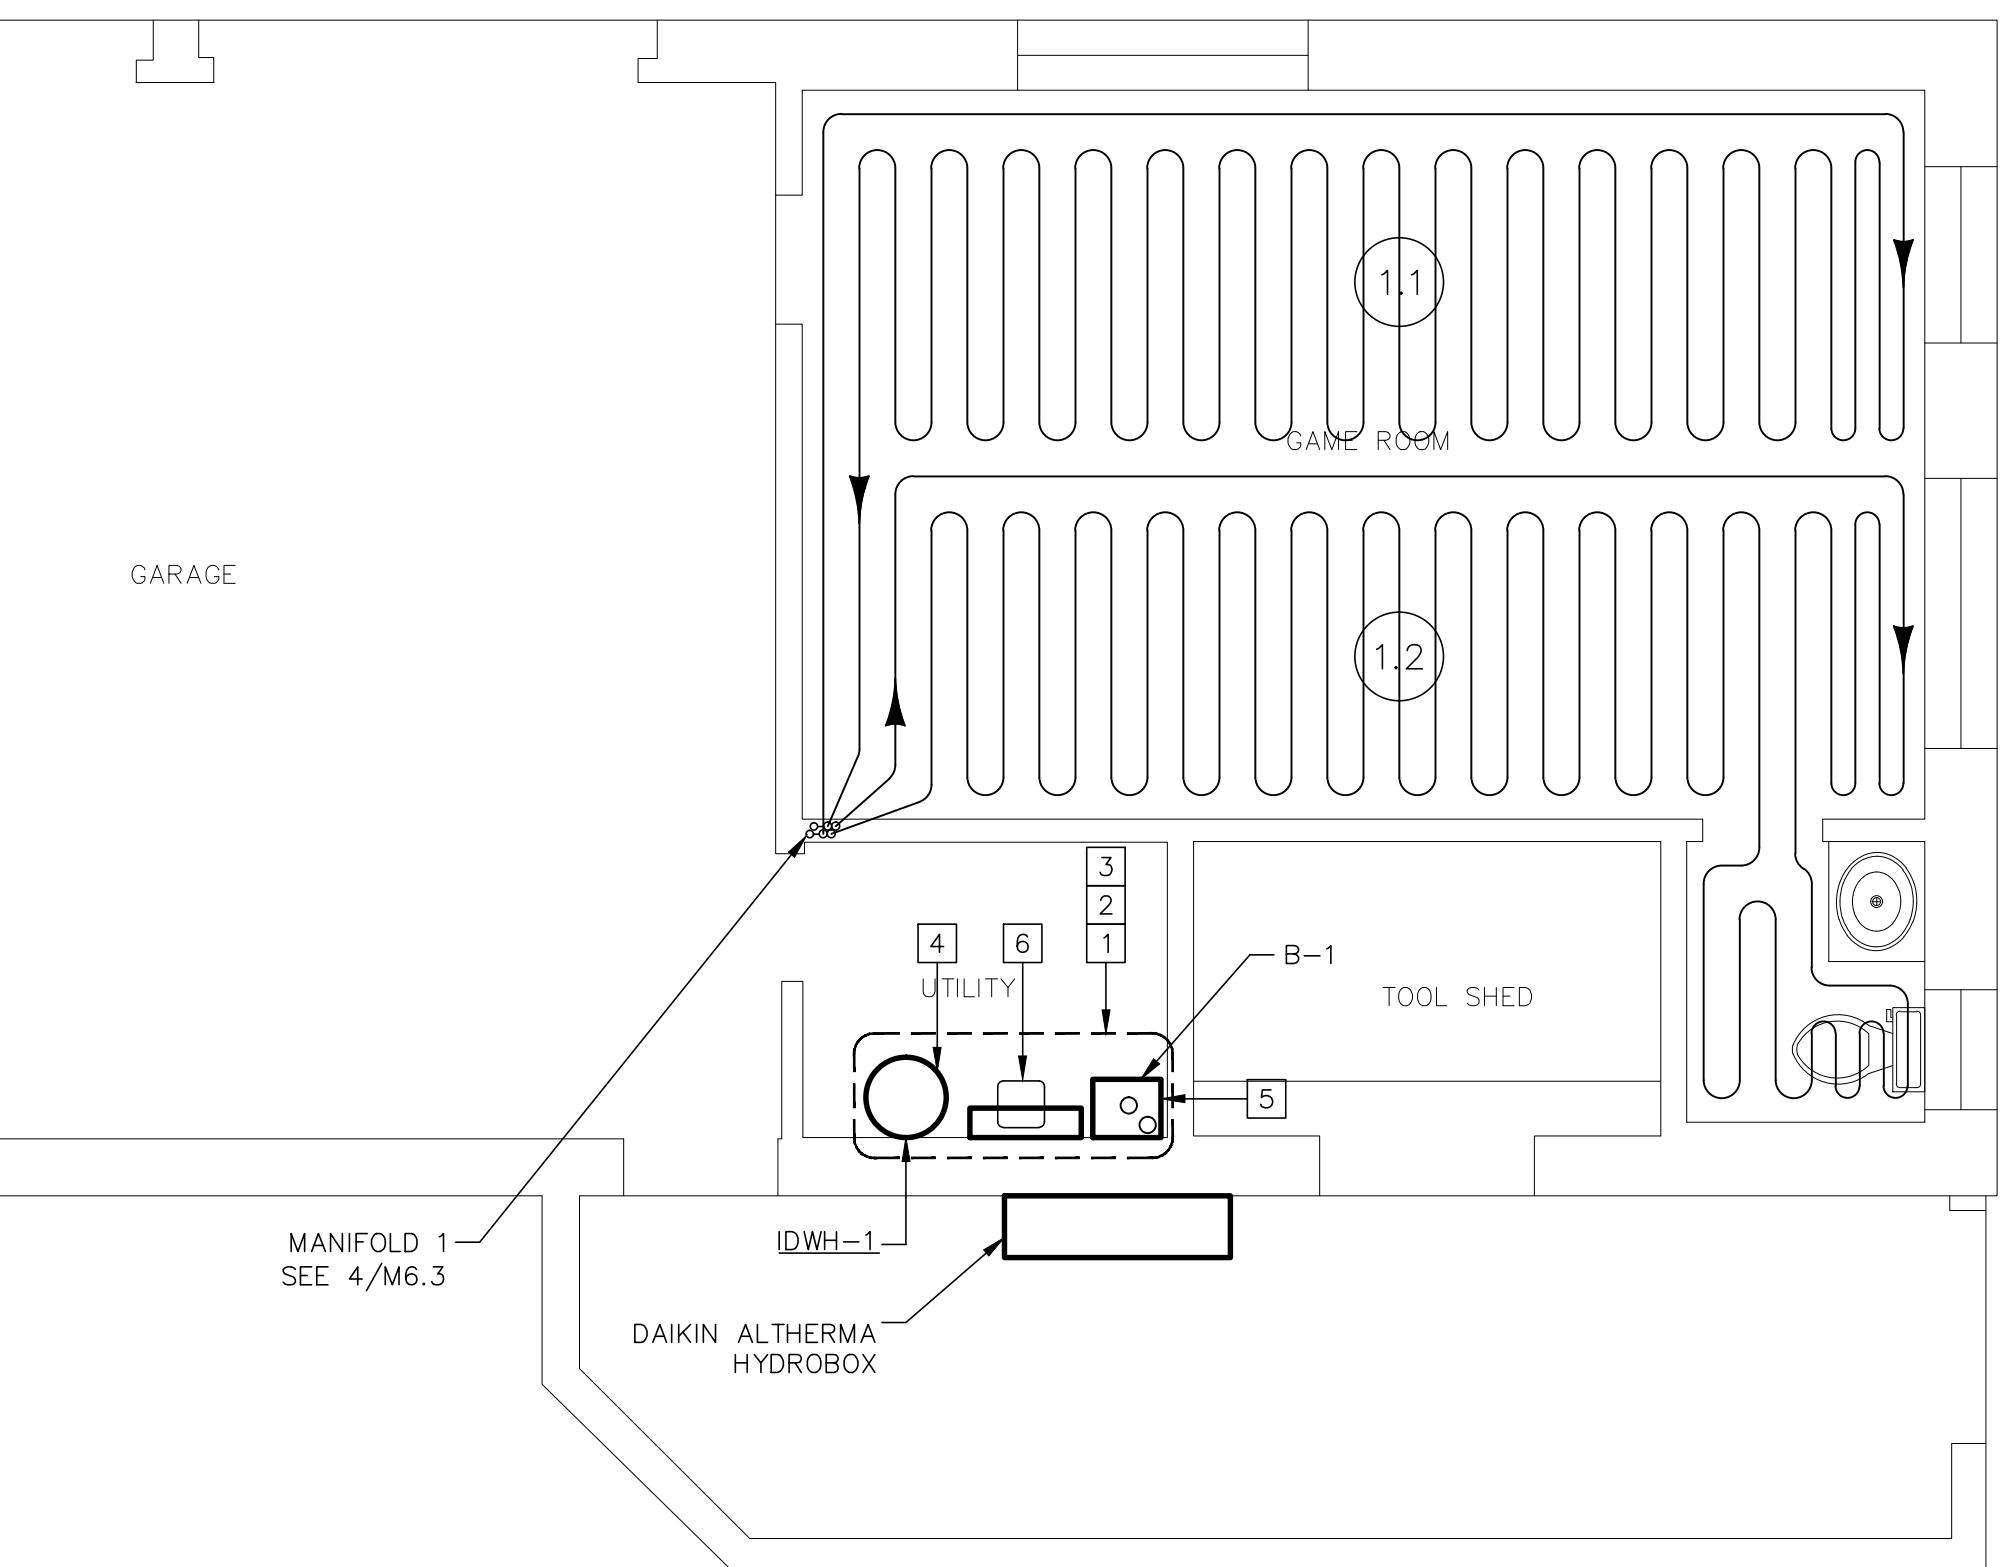


1 RADIANT HEATING PLAN

SCALE: 1/4" = 1'-0"

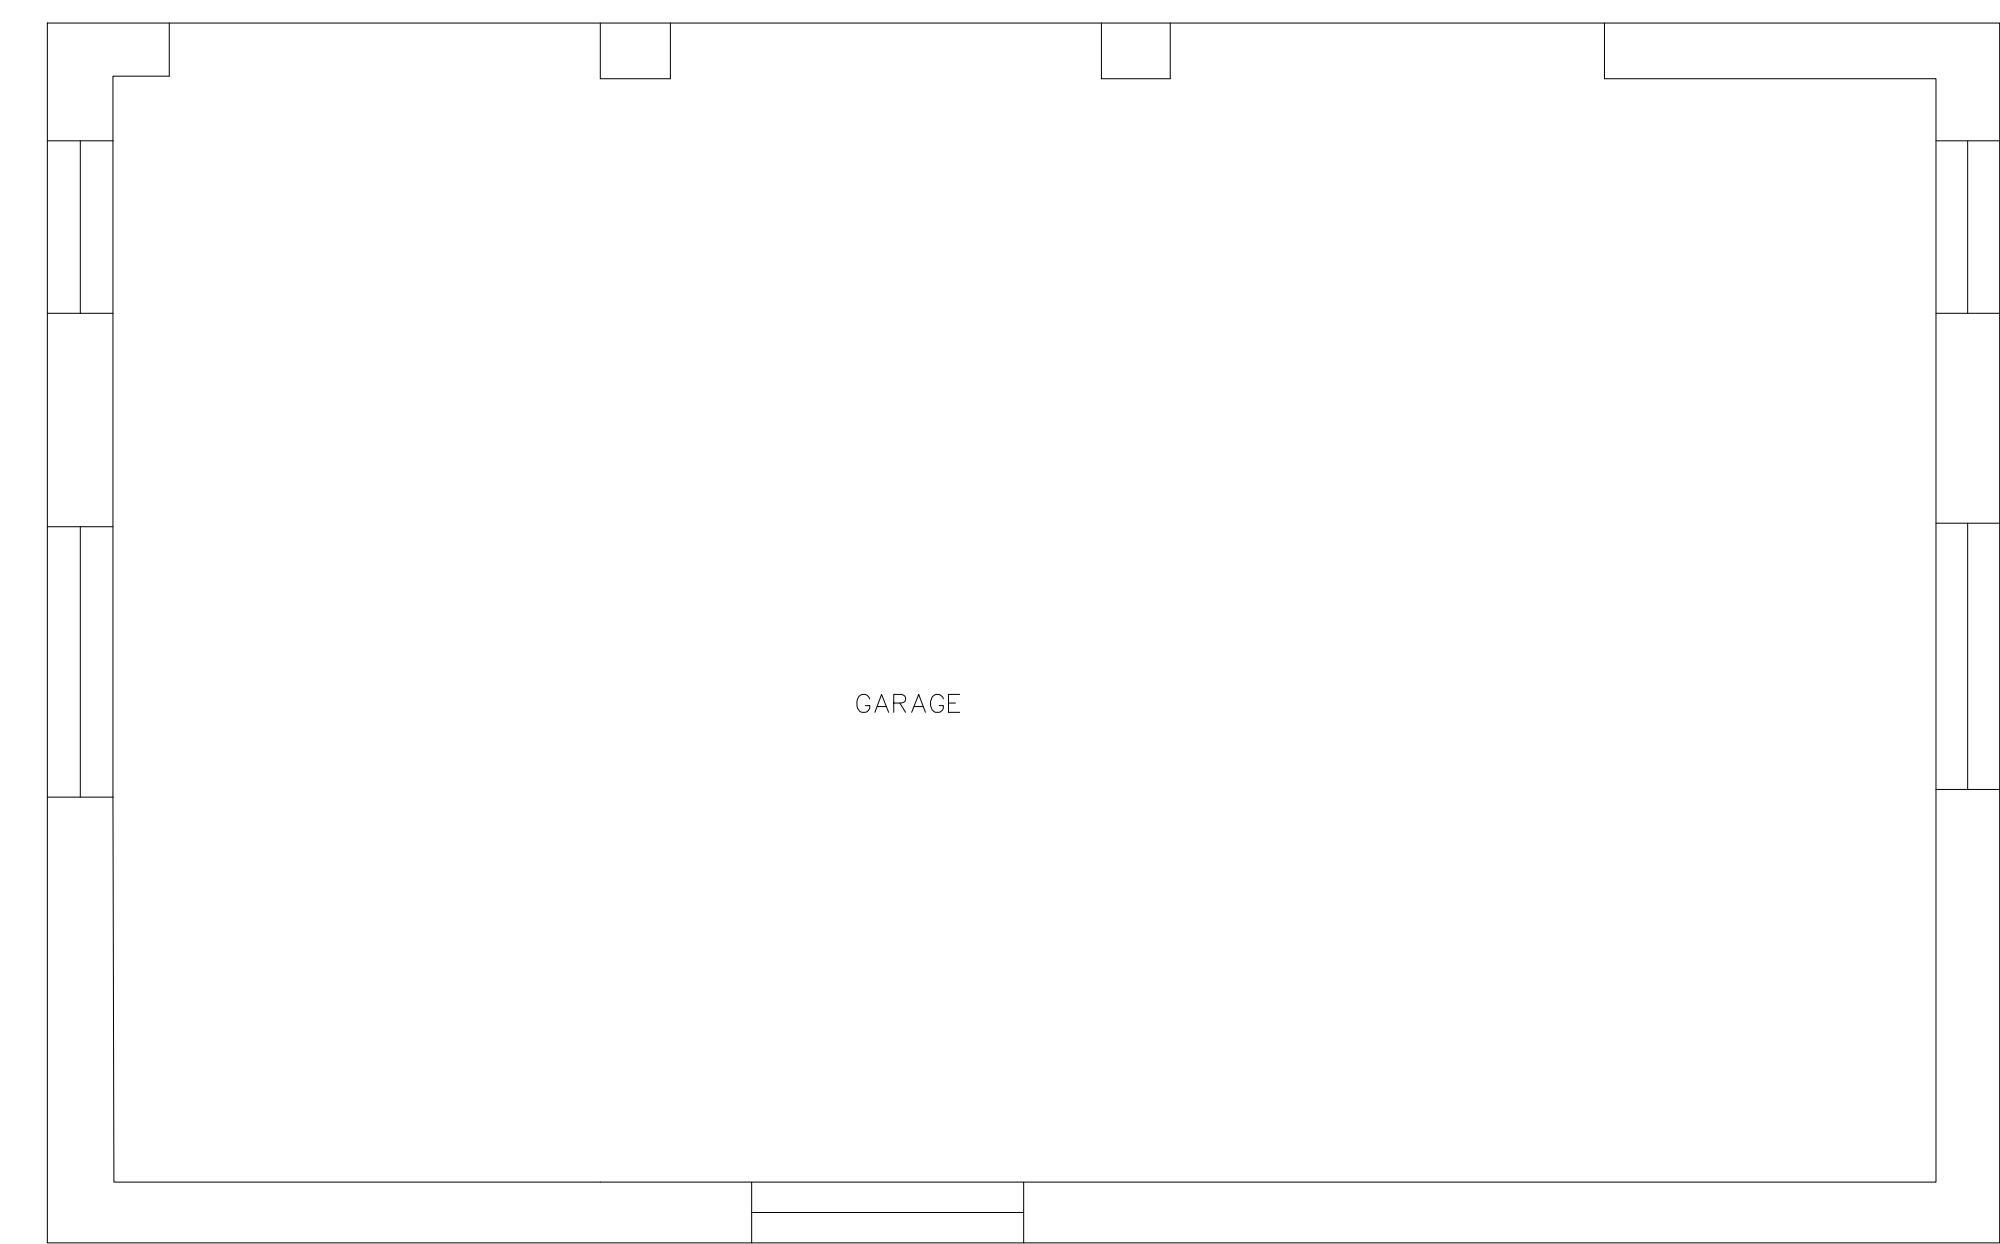

SHEET NOTES

- [1] HEAT SOURCE AND CONTROLS COORD EXACT LOCATION OF EQUIPMENT WITH ARCHITECT AND ALL TRADES BEFORE INSTALLATION OR ORDERING EQUIPMENT.
- [2] PROVIDE A MEANS OF DISCONNECT ADJACENT TO AND WITHIN SITE OF THE EQUIPMENT PER 2010 CMC 309.0 AND A 120V RECEPTACLE WITHIN 25' OF EQUIPMENT, NOT CONNECTED TO THE DISCONNECT.
- [3] NOTE: PROVIDE MANUFACTURER'S INSTALLATION SPECIFICATIONS AND REQUIREMENTS ON SITE FOR FIELD INSPECTION
- [4] PRESSURE RELIEF AND BACKFLOW PREVENTER FOR WATER HEATER PER 2010 CPC 608.5
- [5] HEAT SOURCE VENT PIPING AND TERMINATION TO BE DETERMINED PER OPTIONS ON HEAT SOURCE VENTING SHEET. COORD WITH GENERAL AND PROPOSE OPTIONS TO BE APPROVED BY OWNER AND ARCHITECT.
- [6] PROVIDE WALL OR FLOOR SINK (INDIRECT WASTE) FOR WATER HEATER CONDENSATE REMOVAL AND PRESSURE RELIEF

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RADIANT
HEATING PLAN

DATE: 01/13/2014
SCALE: AS NOTED
DRAWN: MEG
CHECKED:
FILE NAME:
SHEET: M2.1
OF SHEETS

REVISIONS: BY:

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